




SITE PLAN
SCALE 1"=20'-0"

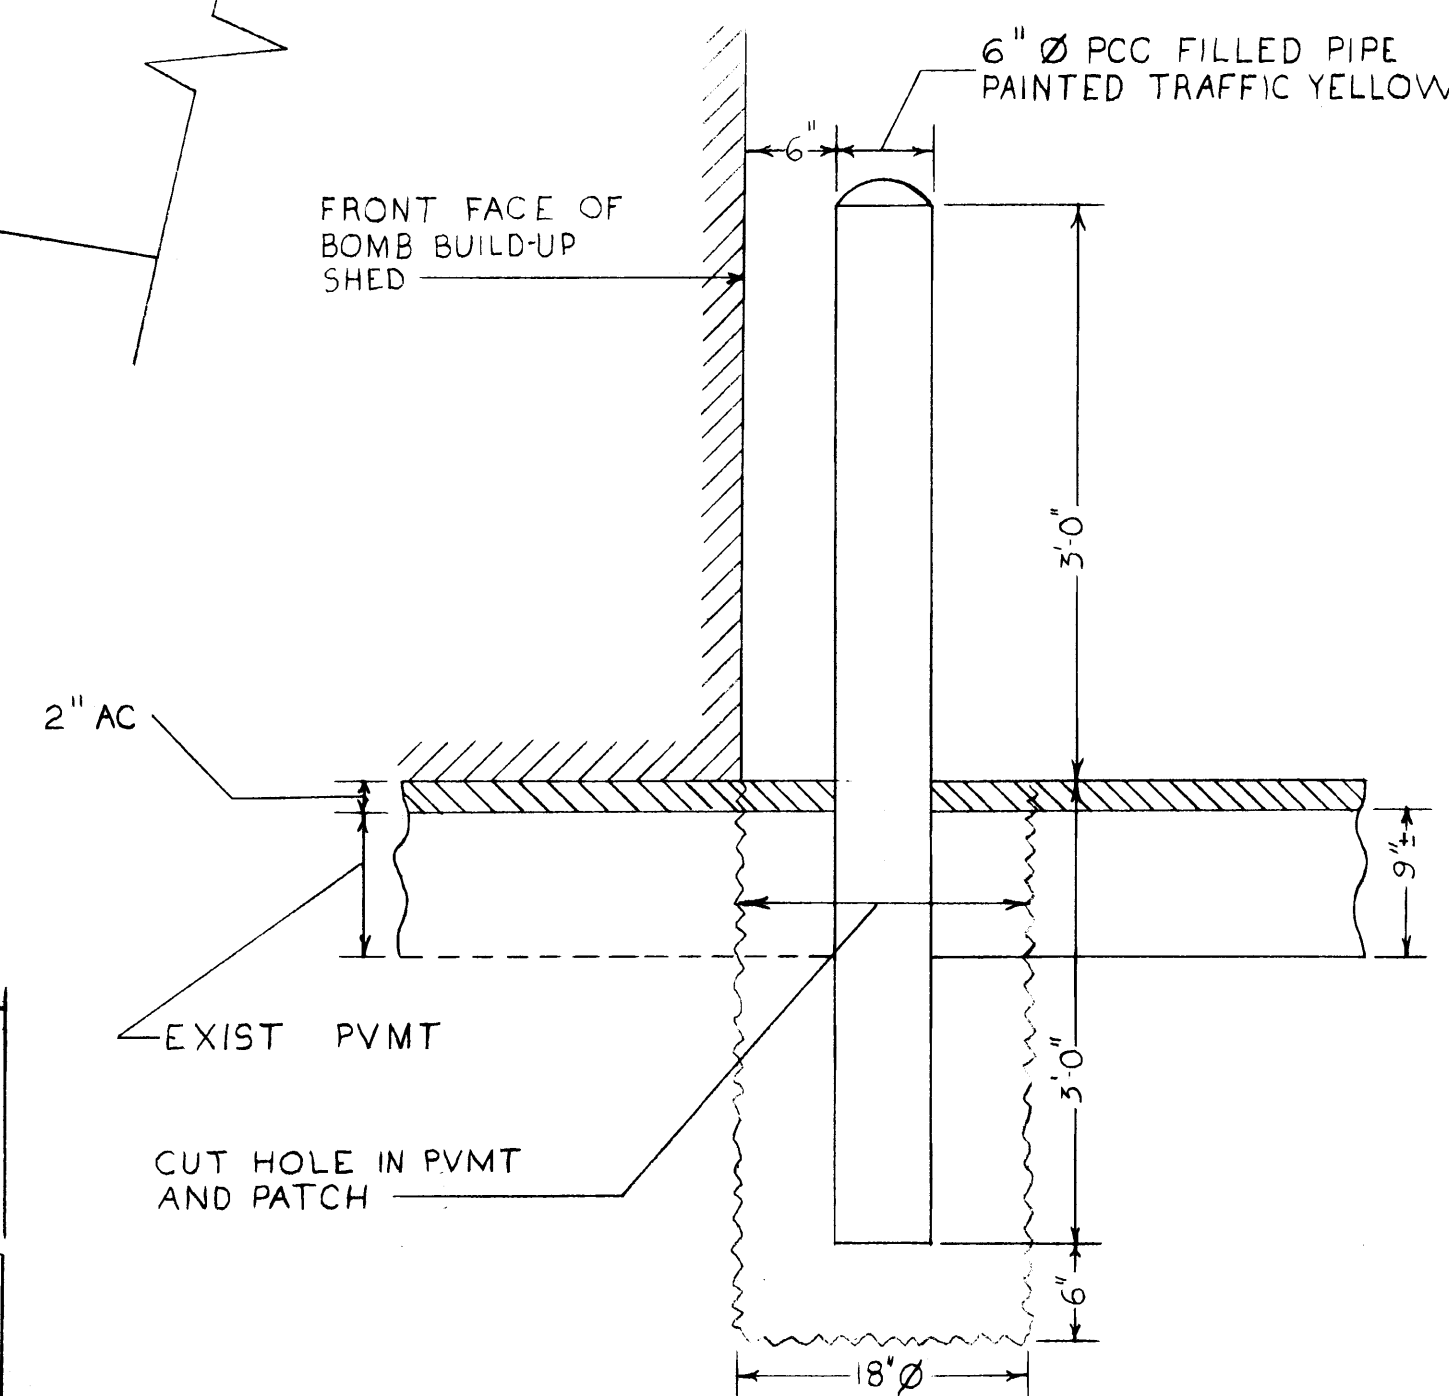


TYPICAL GUARD POST
SCALE 1"=1'-0"

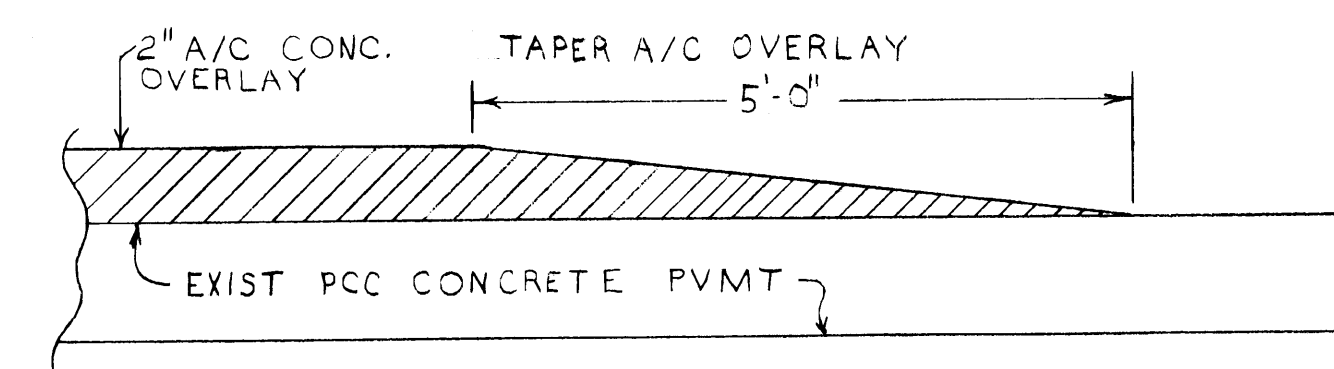


SECTION AA
NOT TO SCALE

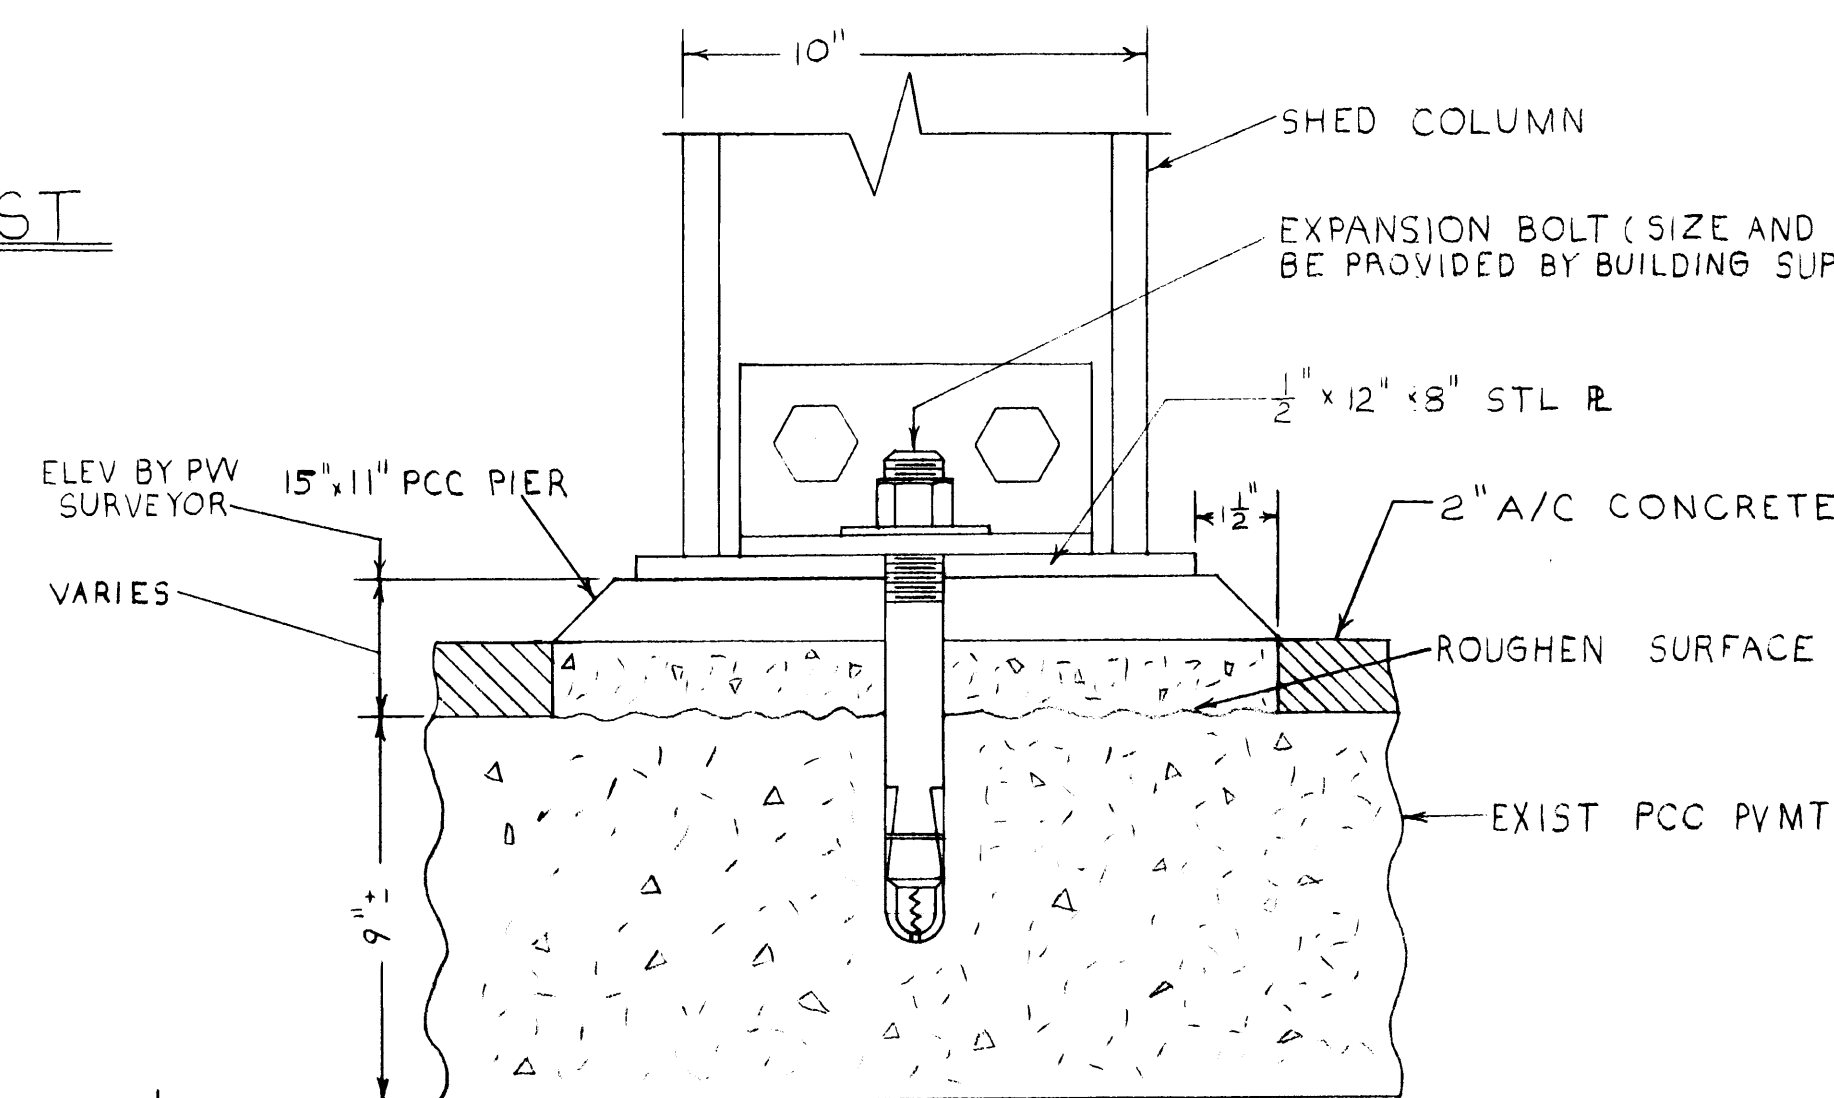

TYPICAL EXPANSION BOLT DETAIL
NOT TO SCALE

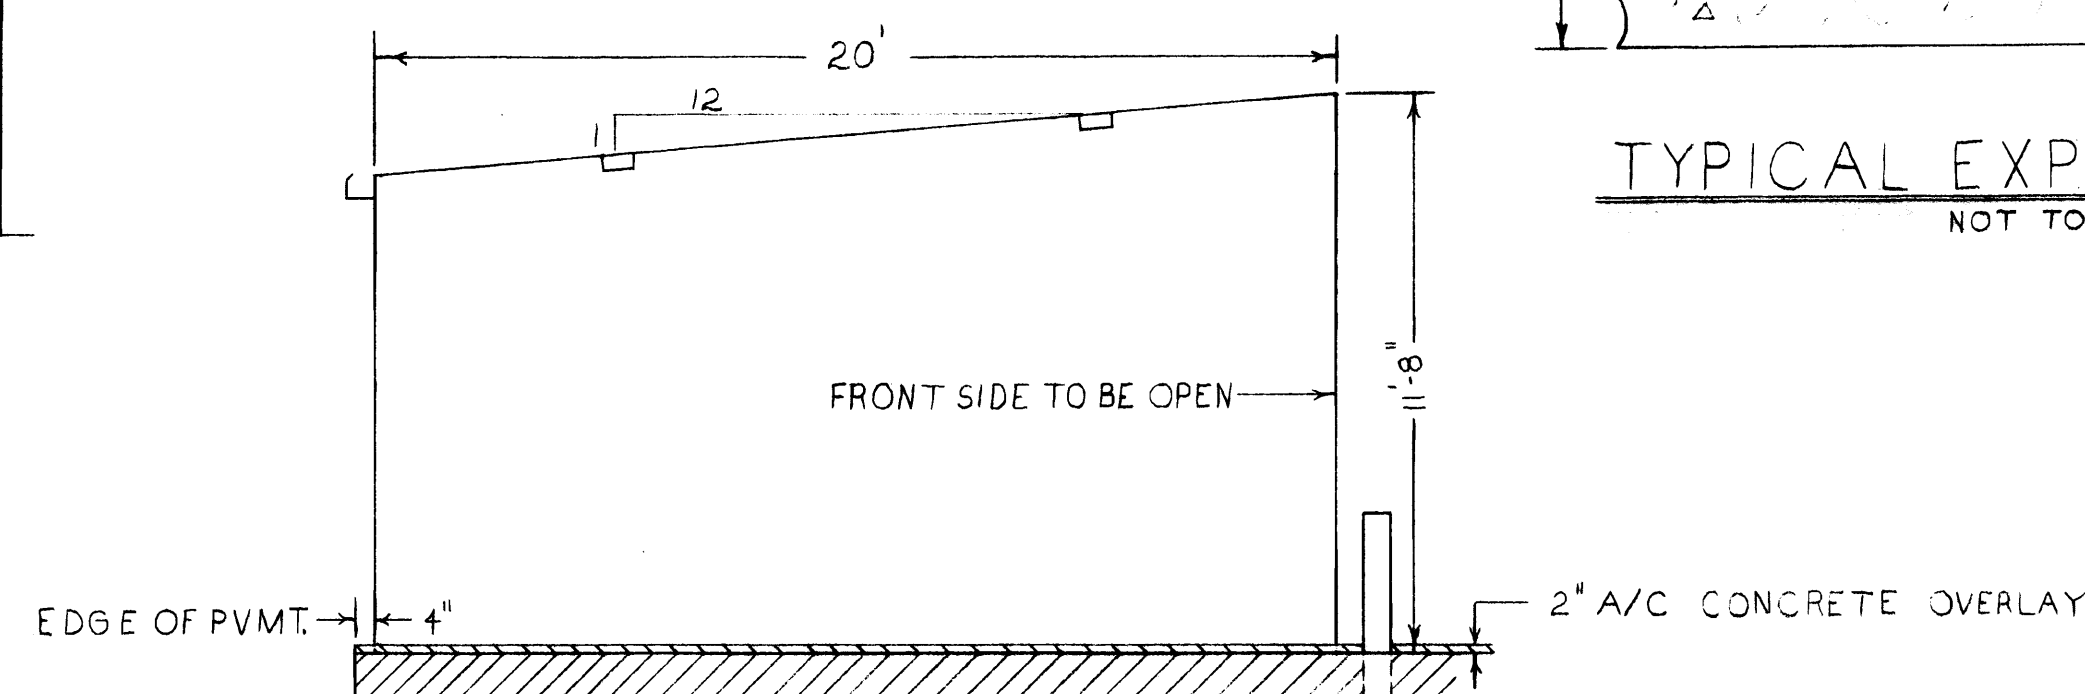

TYPICAL BUILDING SECTION
SCALE 1/4"=1'-0"

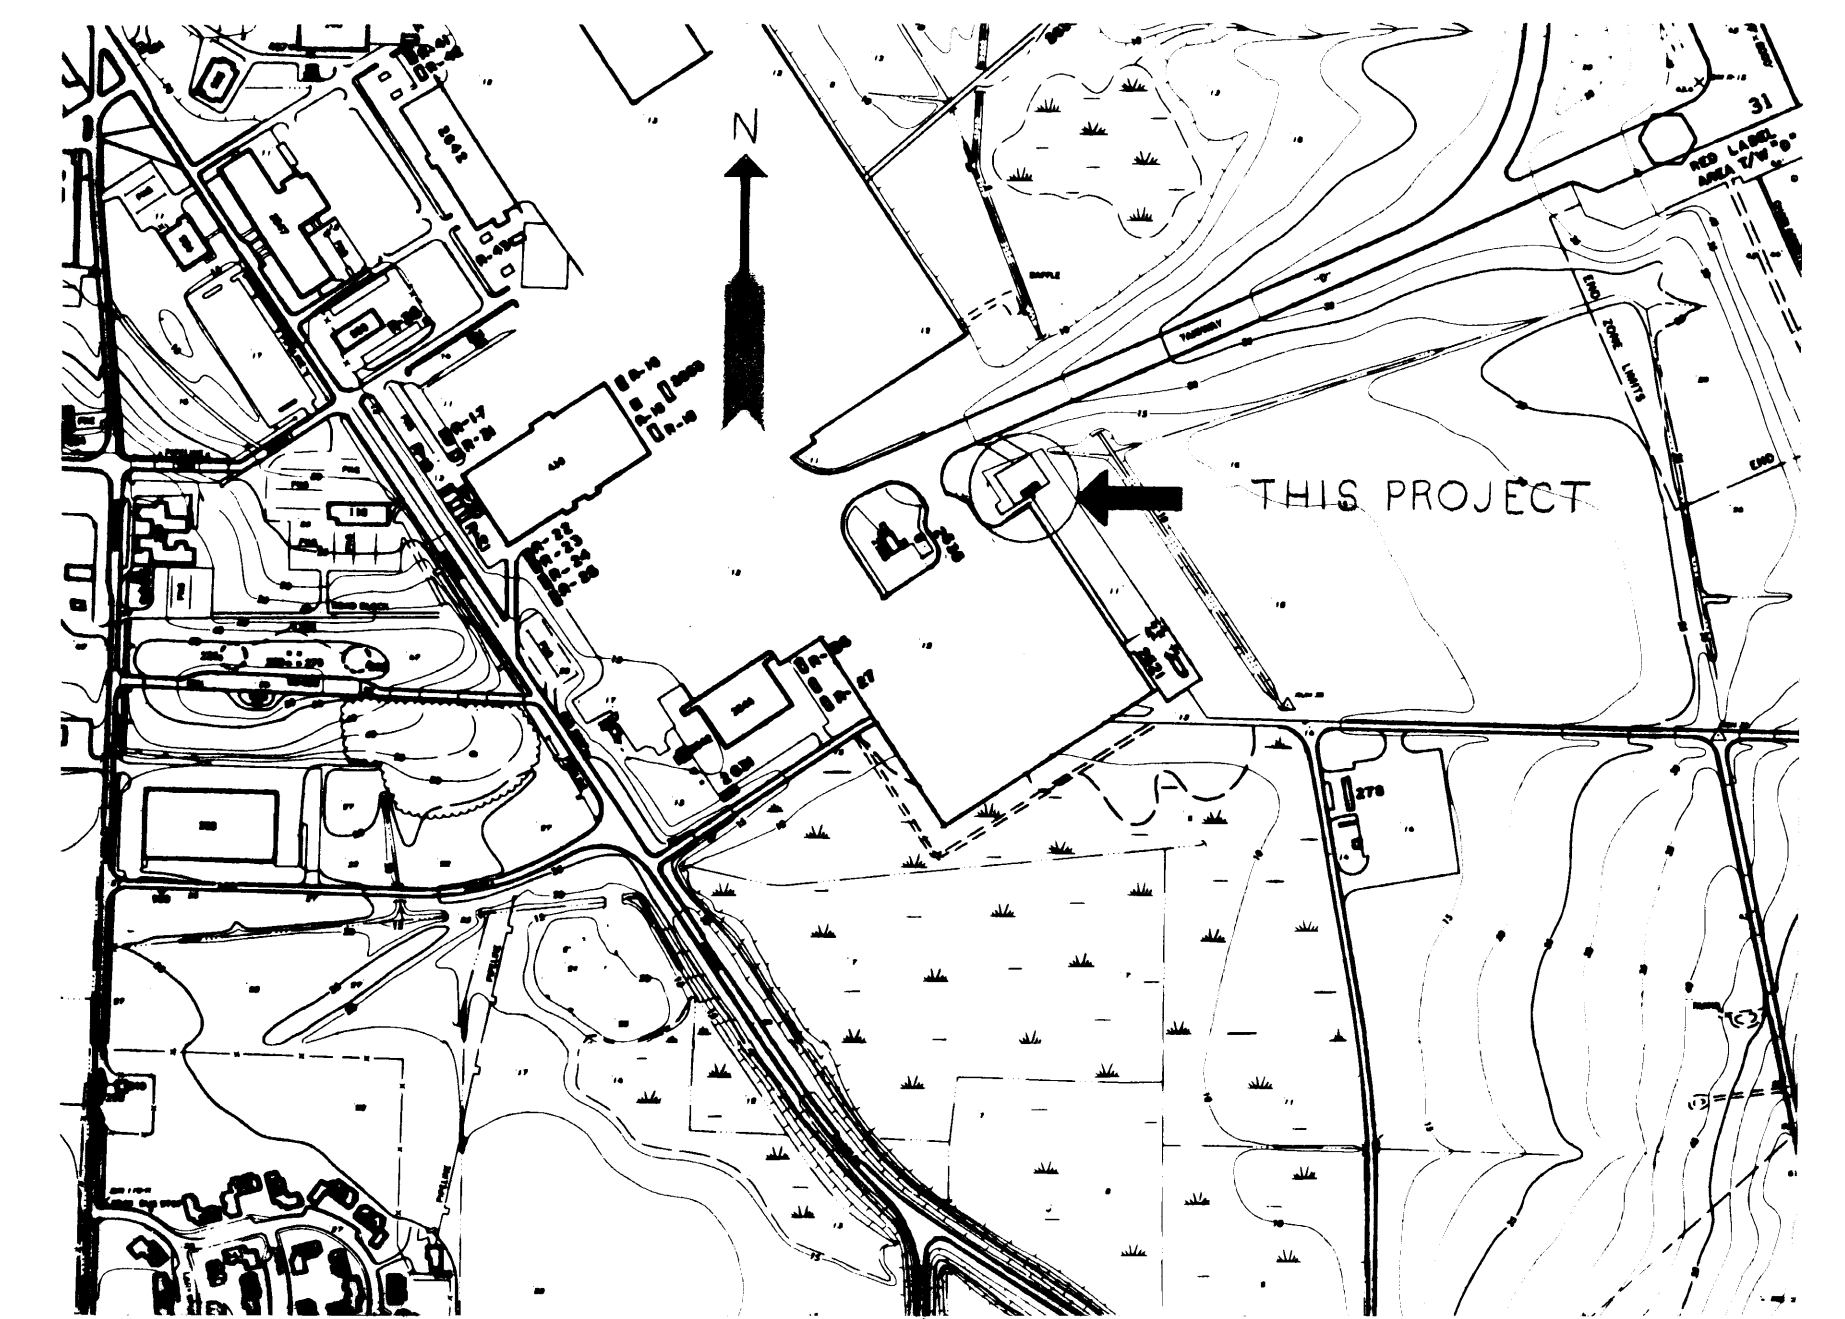

LOCATION PLAN
SCALE 1"=600'

NOTES - GATE AND CHAIN LINK


- CHAIN LINK FENCE SHALL BE 7'-0" HIGH, 9 GAUGE WIRE, 2" MESH.
- CHAIN LINK CORNER POSTS SHALL BE BRACED IN BOTH DIRECTIONS WITH 1 1/2" O.D. SCHEDULE 40 STEEL PIPE HORIZONTAL BRACE & 3/4" DIA. DIAGONAL TRUSS ROD WITH TURNBUCKLE. GATE POSTS SHALL BE BRACED SIMILAR TO CORNER POSTS IN ONE DIRECTION.
- POSTS SHALL BE BURIED IN HOLES FILLED WITH PORTLAND CEMENT CONCRETE (PCC) $f_c = 3,000$ PSI AS NOTED.
- STRETCHER BARS SHALL BE 3/4" x 1/2" x 1/2".
- GATE POSTS SHALL BE 6 3/8" O.D. SCHEDULE 40 STEEL PIPE FOR DOUBLE GATE AND 4" O.D. FOR PERSONNEL GATE. GATE FRAMES SHALL BE 1 1/2" O.D. STEEL PIPE. CHAIN LINK WIRE MESH SHALL BE ATTACHED TO ENDS BY STRETCHER BARS. PROVIDE CROSS BRACING, ADJUSTABLE RODS 3/4" DIA., HARDWARE AS FOLLOWS:
 - HINGES - ONE SET MALLEABLE IRON FOR EACH LEAF, OFFSET TO PERMIT 180° OPENING.
 - LATCH - FORK OR PLUNGER TYPE, OPERABLE FROM EITHER SIDE WITH PADLOCK EYE.
 - PROVIDE FLUSHPLATE WITH ANCHOR SET IN 12" x 30" DEEP CONCRETE TO ENGAGE THE CENTER DROP ROD OR PLUNGER BAR OF THE DOUBLE GATES.
 - PROVIDE LOCKING DEVICE AND PADLOCK EYE INTEGRAL WITH THE LATCH TO ALLOW ONE PADLOCK TO LOCK BOTH GATE LEAVES.
- ALL CHAIN LINK FABRIC SHALL BE HOT DIPPED GALVANIZED WITH 2.0 OUNCES OF ZINC PER SQ. FOOT OF SURFACE AREA. FENCE POSTS, ACCESSORIES, ETC. SHALL BE HOT DIPPED GALVANIZED WITH ZINC COATINGS AS NOTED IN THE SPECIFICATIONS.

BUILDING

- SHED TO BE ORDERED THROUGH THE FOLLOWING GSA CONTRACTOR:
SCHEDULE TITLE: FSC GROUP 54, PART 1, SEC. A - PRE-FABRICATED STRUCTURES, UNFURNISHED BUILDINGS AND ENCLOSURES FSC-5410
CONTRACT NUMBER: 65-085-352-29 AND SUPPLEMENT 1, EXPIRING JANUARY 1, 1983
CONTRACTOR NAME: PORTA HOUSE, INC., 717 KELVIN COURT, P.O. BOX 2226, OAKLAND, CA. 94621 PHONE (415) 638-0100
LOCAL AGENT: PORTA HOUSE, INC., 21716 EAST VALLEY HIGHWAY, KENT, WA 98031 PHONE (206) 872-8985 LAWRENCE F. KUNZ, MARKETING REPRESENTATIVE.
- SHED TO BE A STEEL PRE-ENGINEERED STRUCTURE 20' x 60'. FRONT FACE SHALL BE OPEN. COLUMNS SHALL BE SPACED NO CLOSER THAN 10'-0" ON OPEN FACE. A 3' x 11' PLASTIC LIGHT PANEL SHALL BE PROVIDED FOR EVERY 10' OF BUILDING LENGTH. ROOF AND WALL PANELS BE PROVIDED WITH A FACTORY COATED BAKED ENAMEL FINISH. COLOR SHALL BE 'ISLAND GOLD' WITH WHITE TRIM. GUTTERS AND TWO DOWNSPOUTS SHALL BE PROVIDED FOR EACH SHED. ALONG THE ENTIRE REAR WALL. BUILDING SUPPLIER SHALL PROVIDE 3 SETS OF FOUNDATION AND ERECTION DRAWINGS AND ONE REPRODUCIBLE SET.

A/C PAVEMENT

- PRIOR TO PLACING A/C CONCRETE PVMT, EXIST. PVMT. SHALL BE SWEEP CLEAN AND ALL DEBRIS REMOVED. ALL GRASS GROWING THROUGH PVMT JOINTS SHALL BE REMOVED AND HERBICIDE APPLIED TO THE JOINTS. AFTER JOINTS ARE CLEANED THEY SHALL BE FILLED FLUSH WITH EXIST. SURFACE WITH A/C BASE JOINT SEALER. TACK COAT AND A/C CONCRETE SHALL BE PLACED IN ACCORDANCE WITH OPEN-END CONTRACT NG 2474-82-C-3765.

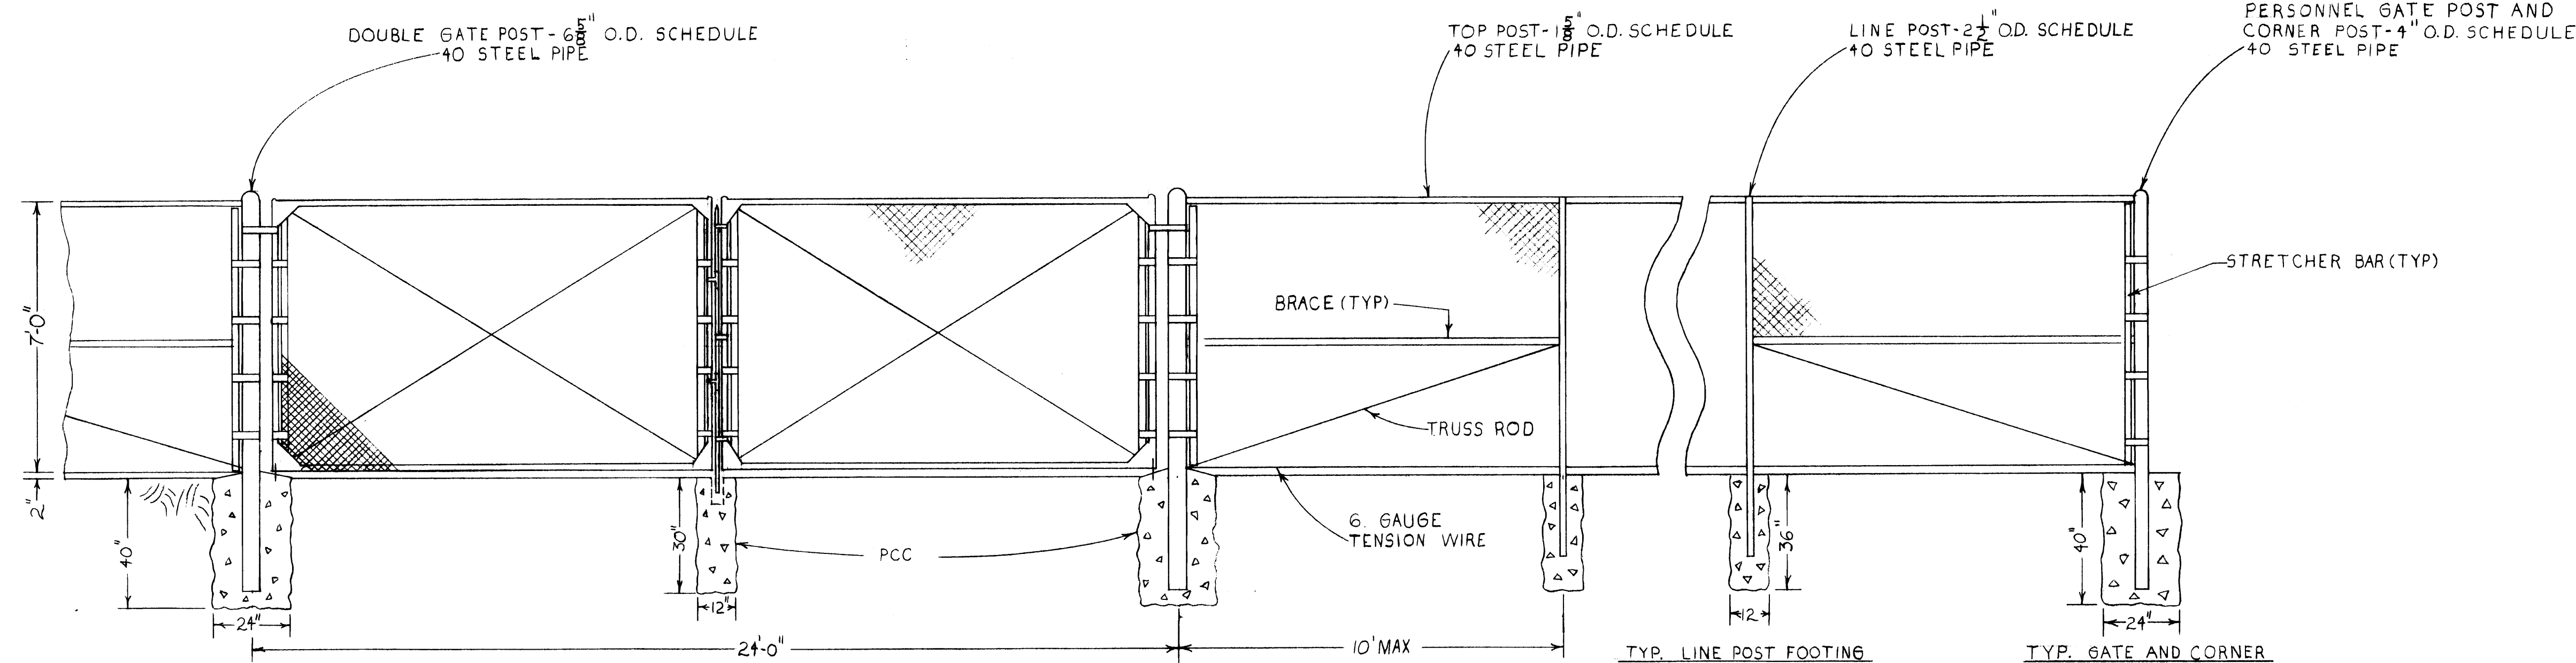

CHAIN LINK FENCE & 24' GATE DETAIL
SCALE 3/8"=1'-0"

NEW POSITION OF SHED PER WESTNAFAC SITE APPROVAL 11 FEB 83		DATE	APPROVAL
BY: P.W. DWS. 83-10	DESCRIPTION: BOMB BUILD-UP SHED BUILDING 2666	DATE: 11 FEB 83	APPROVAL: [Signature]
REVISIONS			
DEPARTMENT OF THE NAVY NAVAL FACILITIES ENGINEERING COMMAND			
NAVAL AIR STATION, WHIDBEY ISLAND			
OAK HARBOR, WASHINGTON			
BOMB BUILD-UP SHED BUILDING 2666			
P.W. DWS. 83-10		DATE: 11 FEB 83	APPROVAL: [Signature]
DRAWN: BEDLINGTON		DATE: 11 FEB 83	APPROVAL: [Signature]
CIVIL		DATE: 11 FEB 83	APPROVAL: [Signature]
ARCH.		DATE: 11 FEB 83	APPROVAL: [Signature]
STRUCT.		DATE: 11 FEB 83	APPROVAL: [Signature]
MECH.		DATE: 11 FEB 83	APPROVAL: [Signature]
ELEC.		DATE: 11 FEB 83	APPROVAL: [Signature]
CIVIL		DATE: 11 FEB 83	APPROVAL: [Signature]
BY: D. J. Powell 18 Feb 1983		DATE: 18 FEB 83	APPROVAL: [Signature]
DIRECTOR: [Signature]		DATE: 11 FEB 83	APPROVAL: [Signature]
APPROVED: [Signature]		DATE: 11 FEB 83	APPROVAL: [Signature]
BATCH/FACTORY TO: [Signature]		DATE: 11 FEB 83	APPROVAL: [Signature]
SIGNATURE: [Signature]		DATE: 11 FEB 83	APPROVAL: [Signature]
TITLE: [Signature]		DATE: 11 FEB 83	APPROVAL: [Signature]
SCALE: AS NOTED		APPROVAL: [Signature]	APPROVAL: [Signature]
SHEET: 01		APPROVAL: [Signature]	APPROVAL: [Signature]

FILE: 2666

1 of 1
NAVAL FACILITIES ENGINEERING COMMAND
NAVAL AIR STATION, WHIDBEY ISLAND
OAK HARBOR, WASHINGTON
83-10